#### JOB DATA

ULTIMATE DESIGN WIND SPEED: 160 NOMINAL DESIGN WIND SPEED: 124 RISK CATEGORY: 2

IMPORTANCE FACTOR: 1.0

BUILDING OCCUPANCY CLASSIFICATION : RESIDENTIAL BUILDING CONSTRUCTION TYPE: 5B

EXPOSURE CATEGORY : B OPENING PROTECTION:

INTERNAL PRESSURE COEFFICIENTS: +0.18, -0.18 (ENCLOSED)

FLOOR LIVE LOAD: I/360 LIVE, I/240 DEAD ROOF LIVE LOAD: I/360 LIVE, I/240 DEAD (SUPPORTING PLASTER CEILING)

THE STRUCTURAL COMPONENTS ON THIS PLANS ARE IN COMPLIANCE WITH THE 6TH EDITION FLORIDA BUILDING CODE, WIND LOAD COMPLIANCE AND ITS RESISTANCE TO GRAVITY AND DESIGN PRESSURES GENERATED BY A WIND VELOCITY OF 170 MPH

WIND VELOCITY (MPH.) IMPORTANCE FACTOR 1.00 **EXPOSURE CATEGORY** INTERNAL PRESSURE COEFFICIENT ( +,-) 0.18 MEAN ROOF HEIGHT (FT) 14'-5" BUILDING WIDTH (FT) 49'-10" BUILDING LENGTH (FT) 54'-8" **ROOF SLOPE** 5:12 **ENCLOSED STRUCTURE** 

AREA SUMMARY					
COVERED LANAI	128 SF				
ENTRY	70 SF				
GARAGE	433 SF				
TOTAL A/C LIVING AREA	1747 SF				
TOTAL UNDER ROOF	2378 SF				


NOTE A: TABLE 722.3.2 MINIMUM EQUIVALENT THICKNESS (in) OF BEARING OR NONBEARING CONCRETE MASONRY WALLS: 2.8 TYPE OF AGGREGATE: CALCAREOUS OR SILICEOUS GRAVEL FIRE-RESISTANCE RATING (hours): 1

DOOR SCHEDULE						
Type Mark	Model	Width	Height	Type Comments	Max. Positive Pressure	Max. Negative Pressure
1	FRENCH DOOR	5' - 4"	8' - 0"	EXTERIOR		
2	SLIDING DOOR	8' - 0"	8' - 0"	EXTERIOR		
3	GARAGE	16' - 0"	8' - 0"	EXTERIOR		
4	SWING	3' - 0"	8' - 0"	EXTERIOR		

INTERIOR DOOR SCHEDULE						
Type Mark	Model	Width	Height	Type Comments	Count	
(2) F-2668	BI-FOLD	5' - 0"	6' - 8"	INTERIOR	2	
(2) F-3068	BI-FOLD	6' - 0"	6' - 8"	INTERIOR	2	
2668	SWING	2' - 6"	6' - 8"	INTERIOR	4	
2868	SWING	2' - 8"	6' - 8"	INTERIOR	2	
3068	SWING	3' - 0"	6' - 8"	INTERIOR	1	
F-2468	BI-FOLD	2' - 4"	6' - 8"	INTERIOR	1	
P-2668	POCKET	2' - 8"	6' - 8"	INTERIOR	1	

WINDOW SCHEDULE							
Type Mark	Width	Height	Description	Comments	Count	Max. Positive Pressure	Max. Negativ Pressu
25	3' - 0"	5' - 2"	SINGLE HUNG		4		
78	2' - 2"	2' - 2"	SINGLE HUNG		1		
79	3' - 0"	3' - 0"	SINGLE HUNG		1		


NOTE: CONTRACTOR TO VERIFY WINDOWS AND DOORS ROUGH OPENINGS AS PER THE MANUFACTURER SPECIFICATIONS.

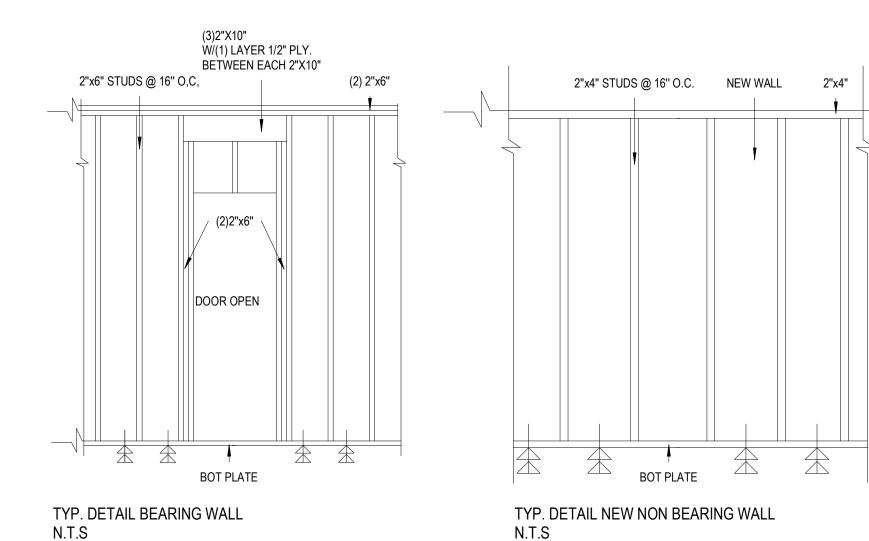

NO ILL FASTERNERS-VERIFY WITH PRODUCT APPROVAL CONTINUOUS URETHENE SEALANT BEAD STOOL PER SPEC BETWEEN FLANGE BLOCK SEAL WINDOW TO BLOCK 1 X P.T NAILERS -ATEPPED PRE-CAST CONCRETE SILL WATER PROOFING COAT 1/2" GYPSUM WALLBOARD APPLY ON SILL EXTENDED 6" DOWN AND 6" UP THE MASONRY WALL CEMENTITIOUS FINISH ISULATION/FURRING -

DETAIL A N.T.S



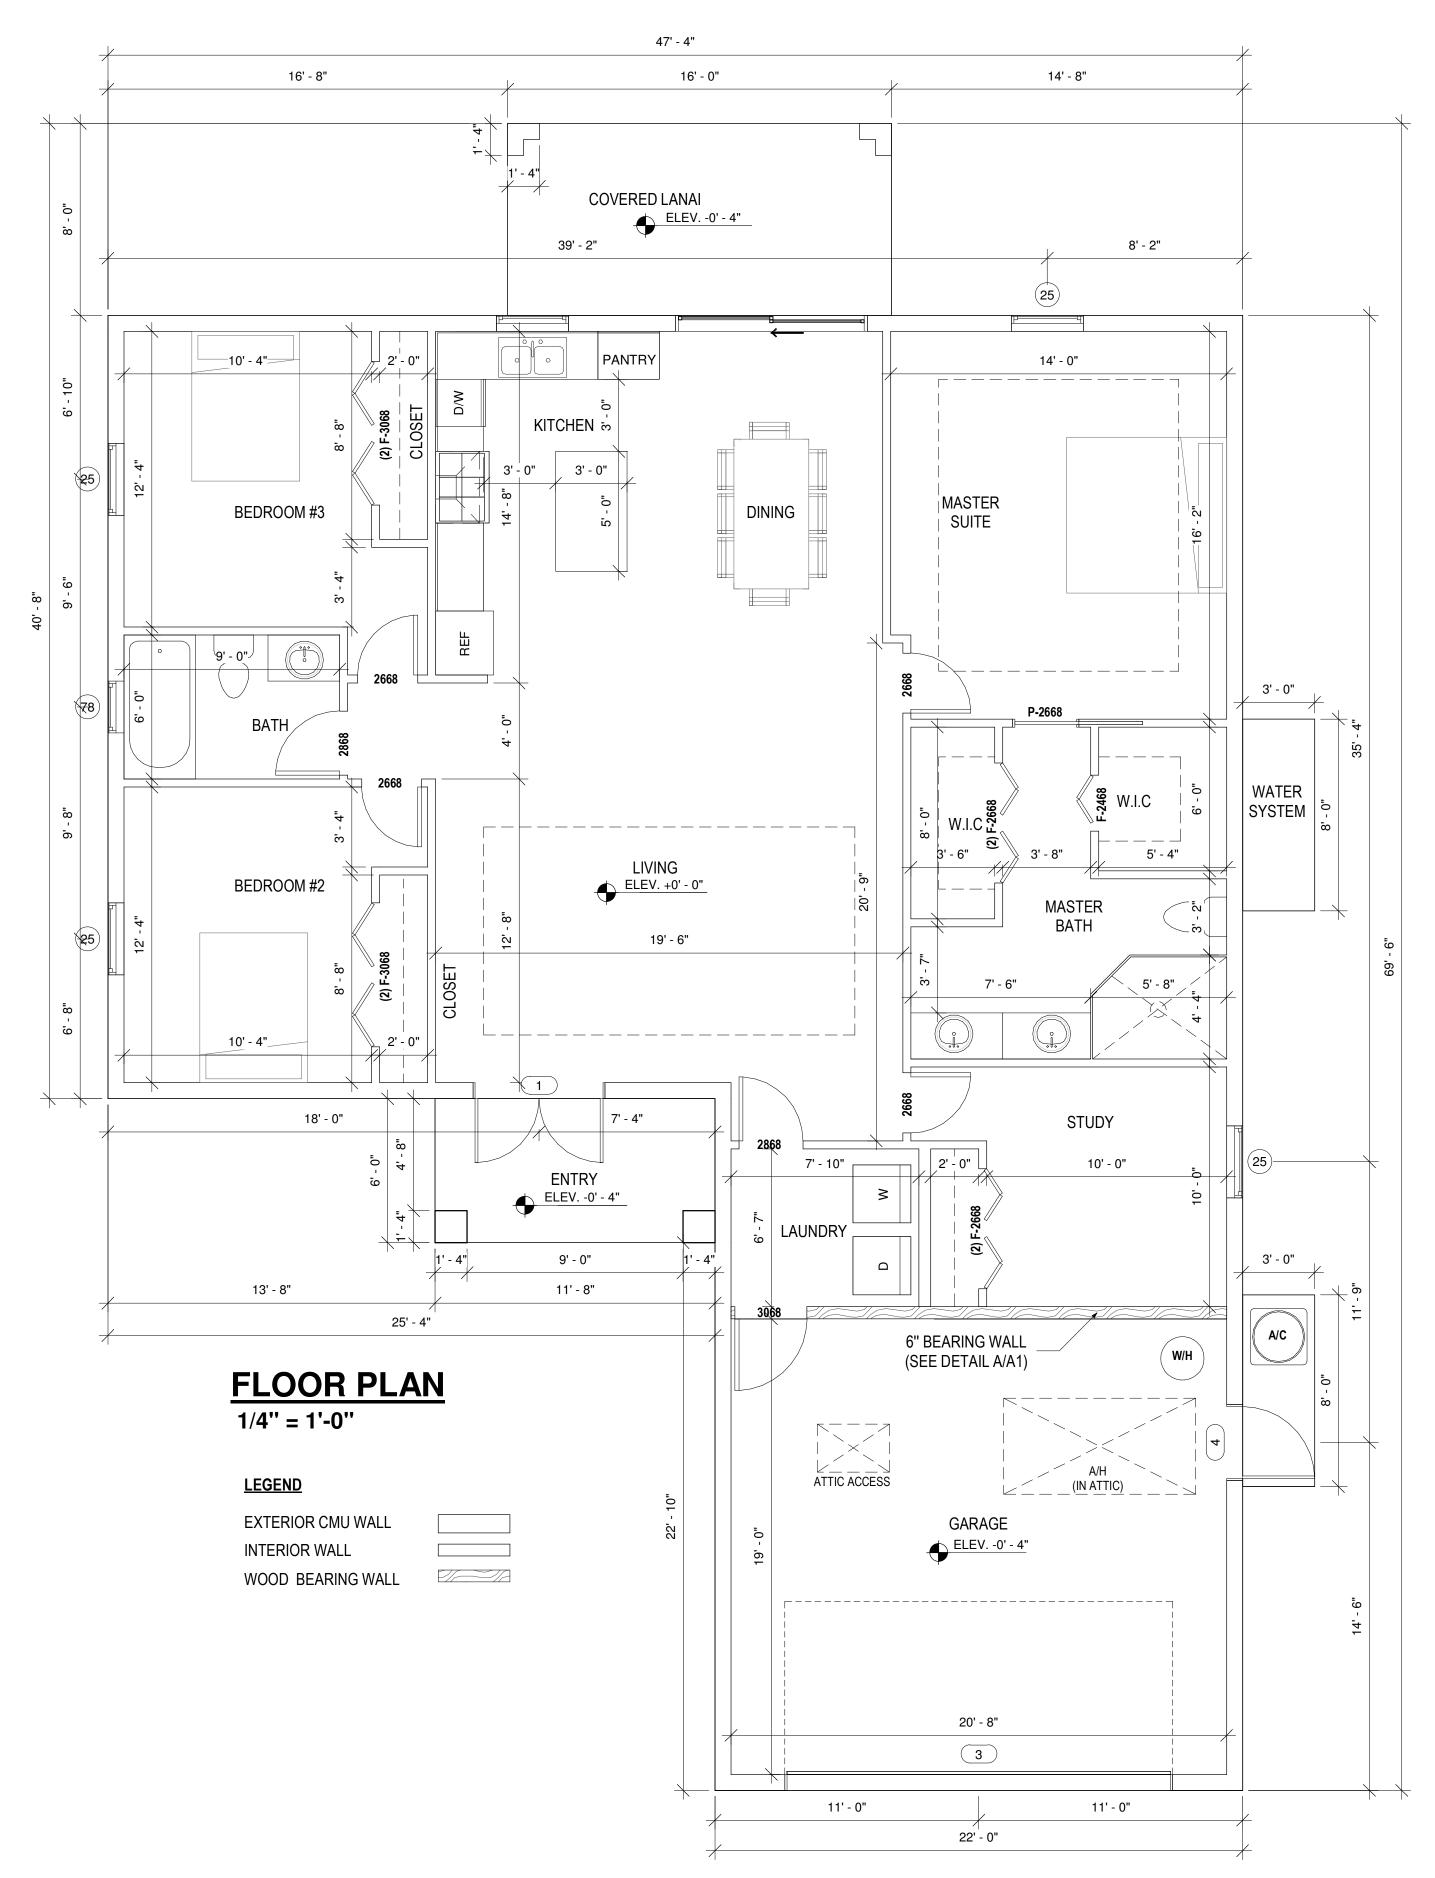



ANY QUESTIONS REGARDING THE DRAWINGS, DESIGNS AND INFORMATION REPRESENTED HEREIN PLEASE CONTACT:

#### **OLYMPUS DESIGNS GROUP**

5621 STRAND BLVD, SUITE 308 NAPLES, FL 34110 239 306-2324 info@olympusdesigns.net

## **REVISIONS** Description Date

#### APPLICABLE CODES

-6TH EDITION (2017) FLORIDA BUILDING CODE -6TH EDITION (2017) FLORIDA EXISTING CODE -2014 STANDARD NATIONAL ELECTRICAL CODE

DIGITAL SEAL

THIS DESIGN HAS BEEN PREPARED UNDER SUPERVISION, DIRECTION AND CONTROL OF:

MG Engineering Consulting Services, Inc. 3640 19th/ Ave SW Naples, FL 34117 Phone: (239) 595 5465 maxguerra@mg-engineering.us M





Project Number 12/20 JG Drawn by


**A1** 

As indicated

G 816 BELL BLVD S. - 10424602 **FLOOR PLAN** 

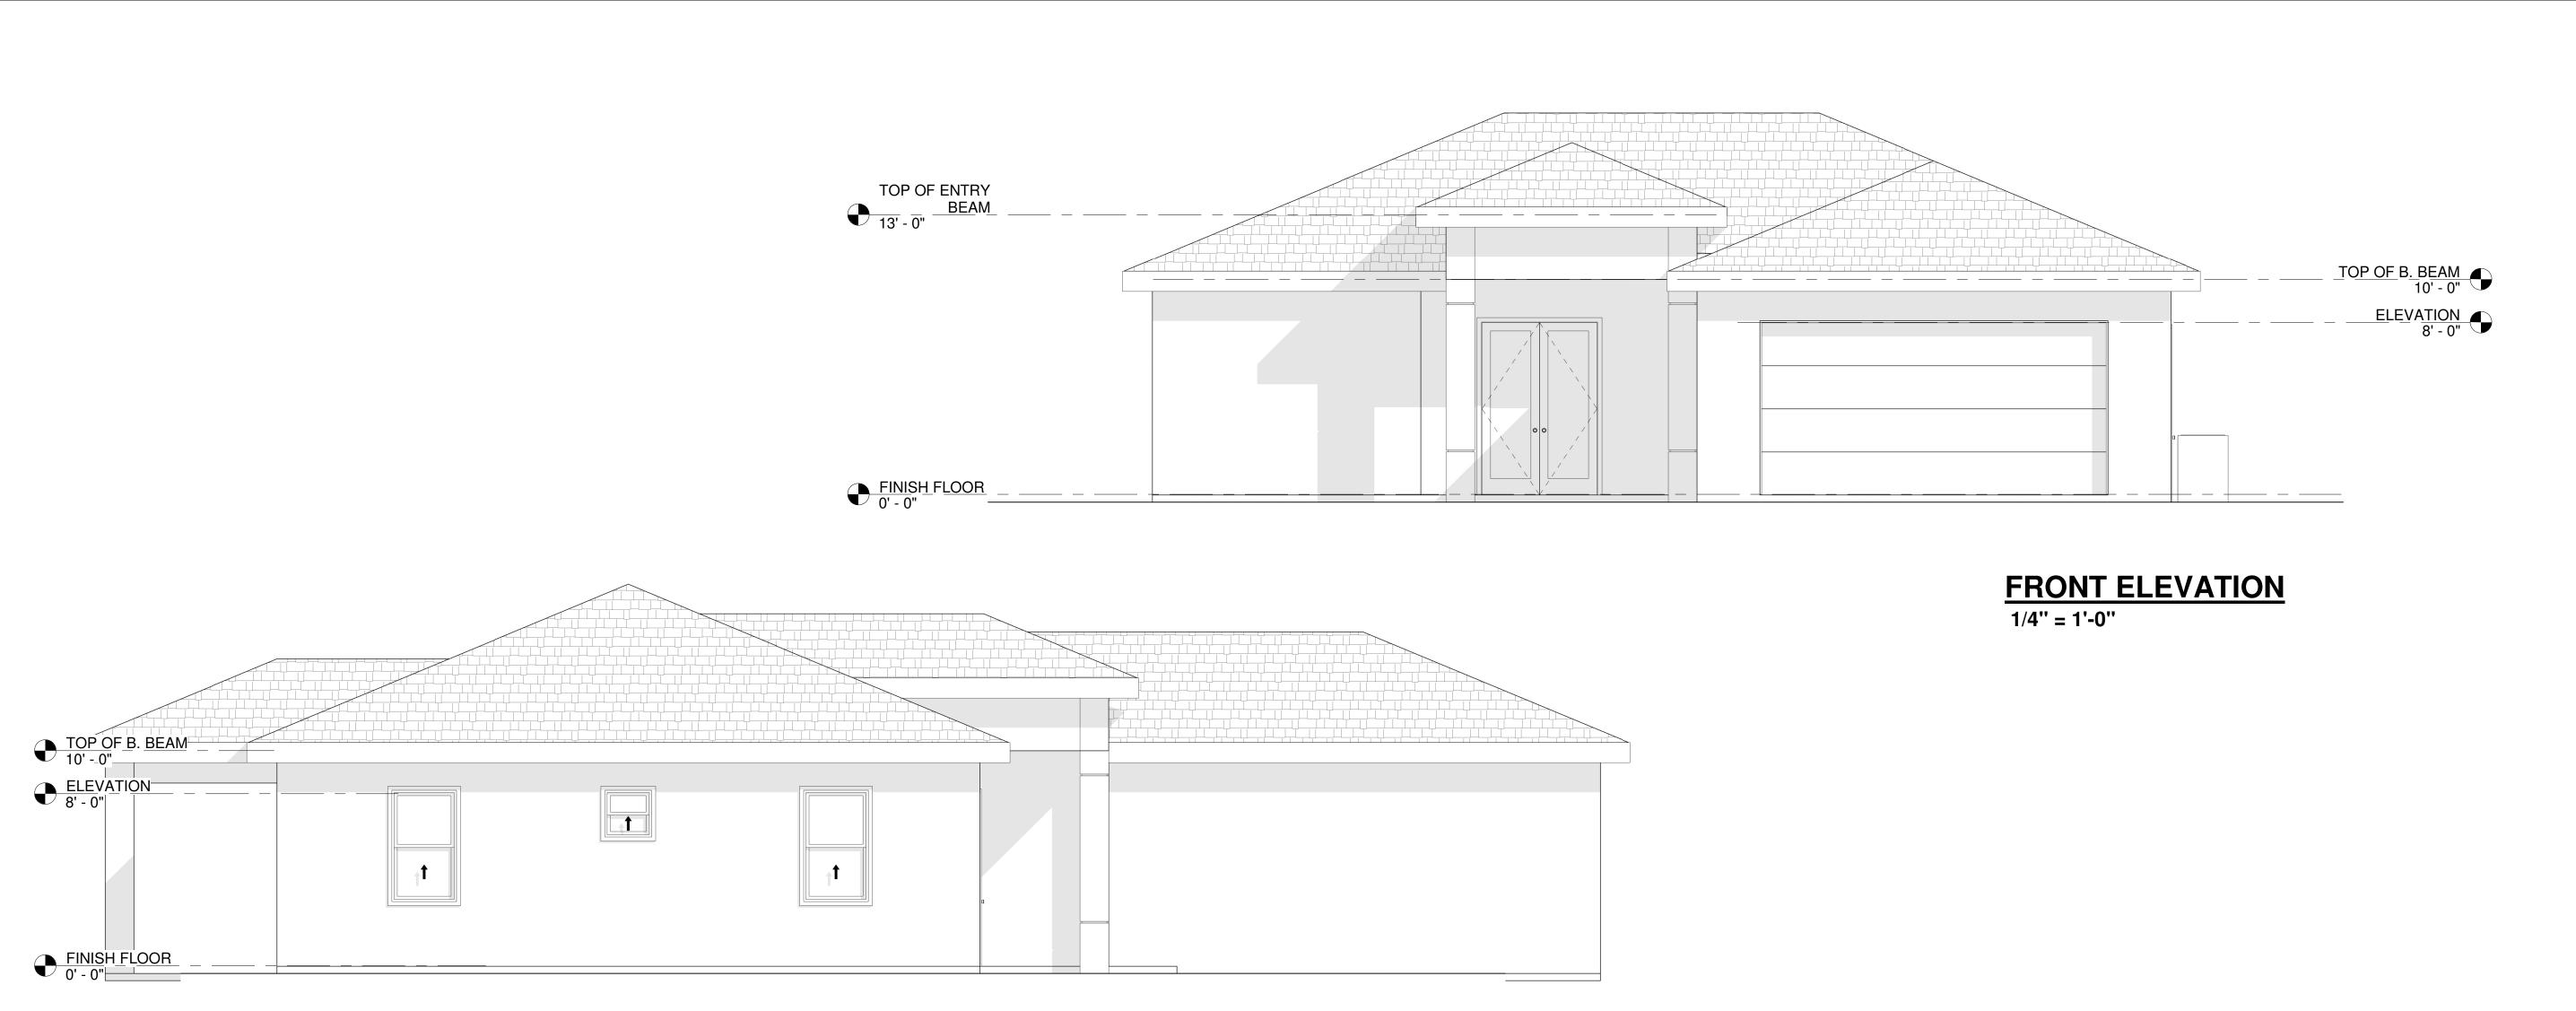

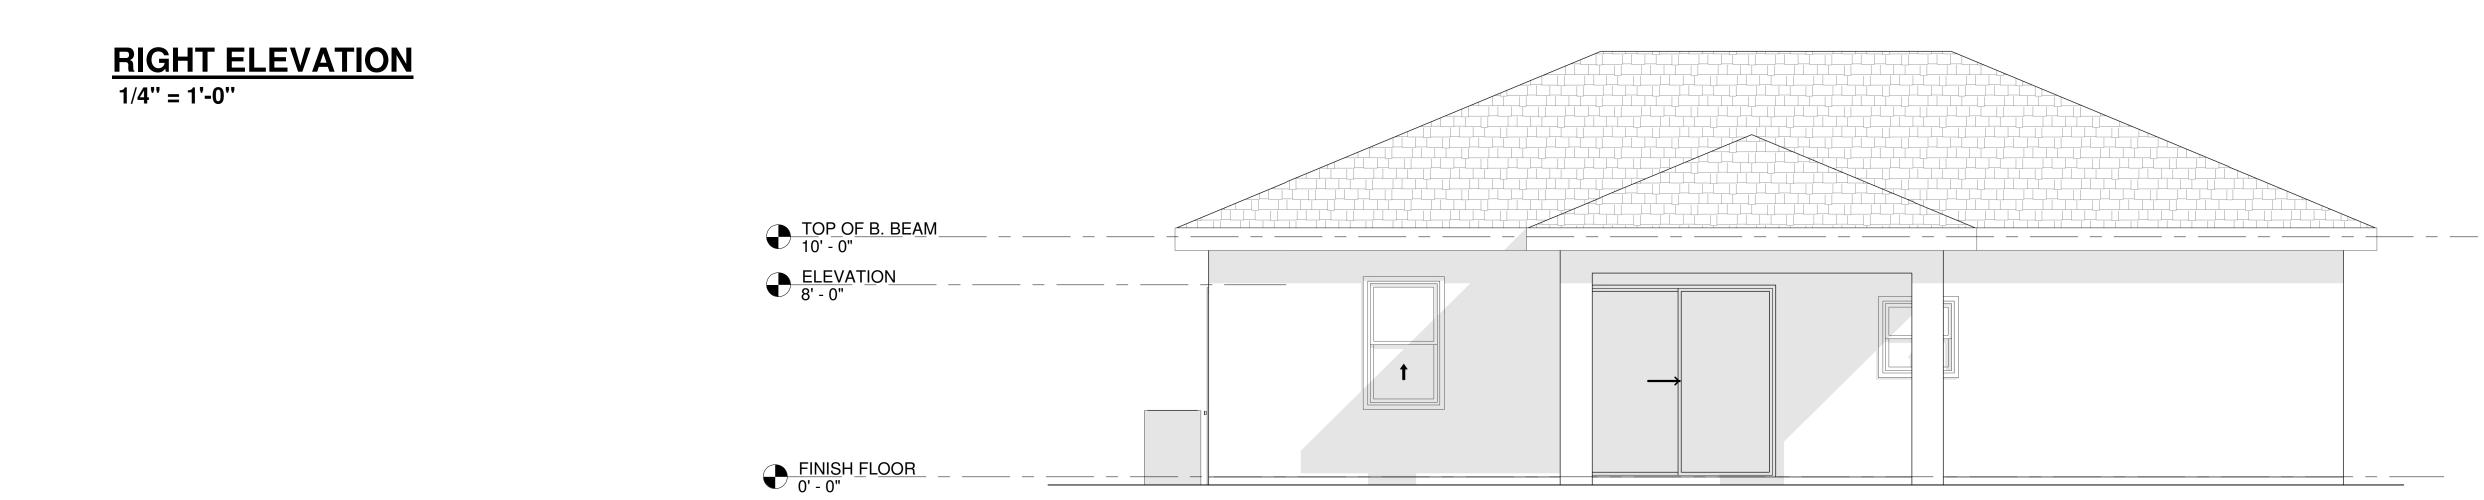

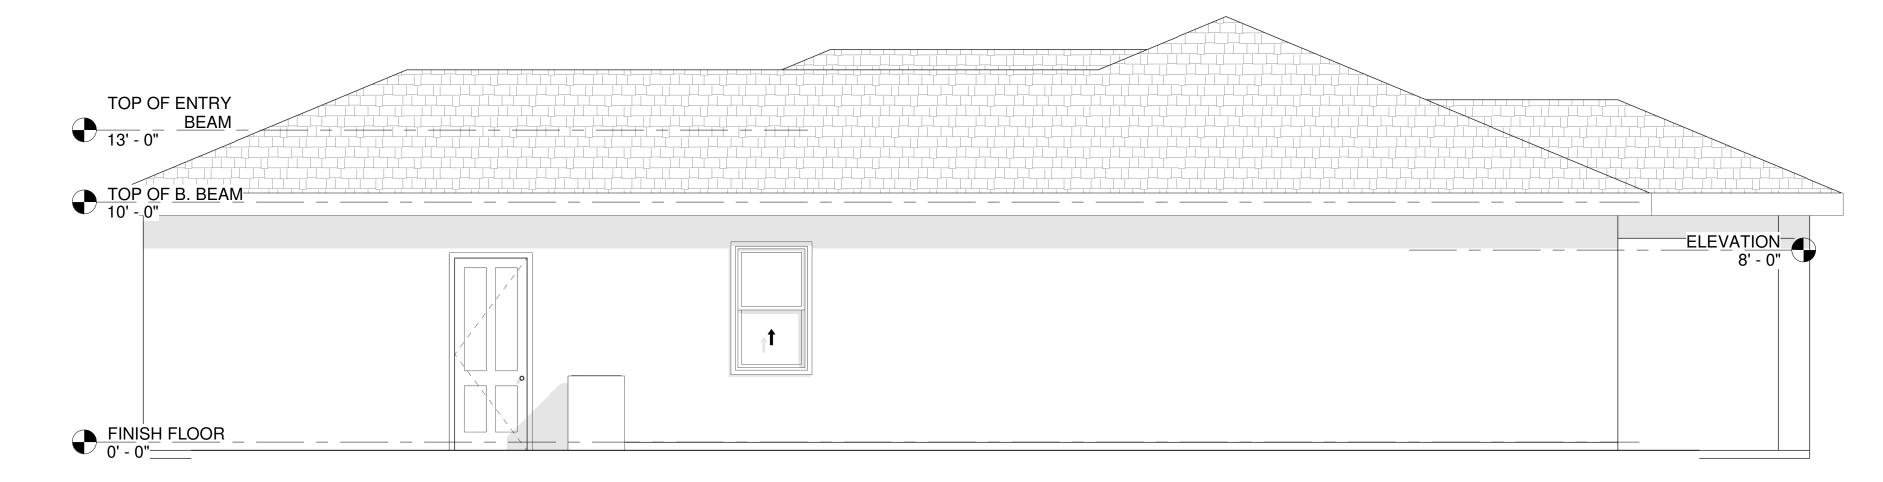



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#### <u>REVISIONS</u>

Description	Date
	Description

#### APPLICABLE CODES


-6TH EDITION (2017) FLORIDA BUILDING CODE -6TH EDITION (2017) FLORIDA EXISTING CODE -2014 STANDARD NATIONAL ELECTRICAL CODE

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**REAR ELEVATION** 1/4" = 1'-0"



# YABEYIRE SERVICES INC

816 BELL BLVD S. - 10424602
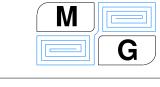
### **ELEVATIONS**

Project Number	
Date	12/20
Drawn by	JG
Notes	DS

**A3** 

Scale 1/4" = 1'-0"

<u>LEFT ELEVATION</u> 1/4" = 1'-0"